# Verizon




ZONING DRAWINGS

- NOT FOR CONSTRUCTIO

TARPON TOWERS: MA 1231 VZW PROJECT ID: 17361979

CALL ROAD COLRAIN, MA 01340

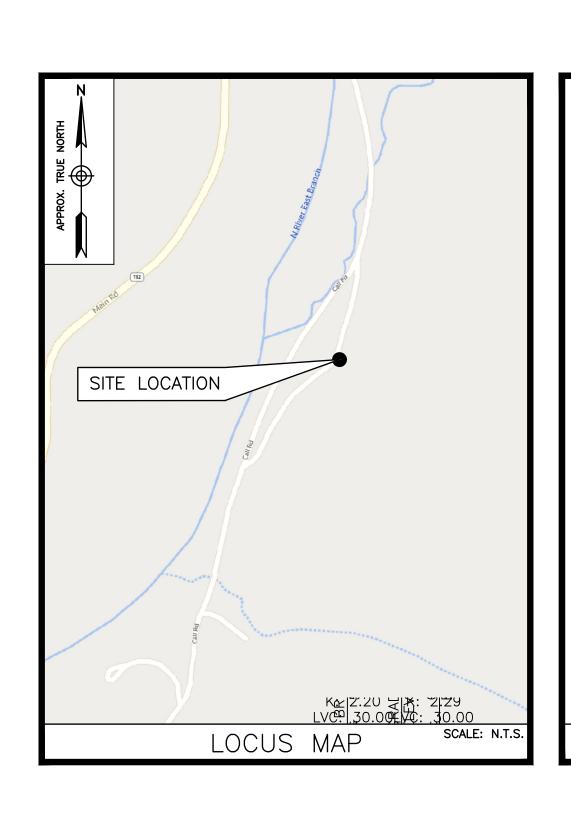

# ENGINEER DEWBERRY ENGINEERS INC. 99 SUMMER ST. SUITE 700 BOSTON, MA 02110 PHONE # (617) 531-0813 FAX # (617) 695-3310 CONTACT: BENJAMIN B. REVETTE, PE PROJECT MANAGEMENT TARPON TOWERS III,LLC 8916 77TH TERRACE EAST SUITE 103 LAKEWOOD RANCH, FL 34202

TEAM

VERIZON WIRELESS SITE INFORMATION:
PROJECT ID: 17361979

TARPON SITE INFORMATION:
PROJECT ID: MA1231

PROPERTY OWNER: MICHAEL J. BAILEY, JR

MAP/PARCEL: 4120-0004-00010

APPLICANTS:
VERIZON WIRELESS
51 ALDER STREET
MEDWAY, MA 02053

TARPON TOWERS III, LLC 8916 77TH TERRACE EAST SUITE 103 LAKEWOOD RANCH, FL 34202

ELECTRIC UTILITY:
NATIONAL GRID
(800) 322-3223

MONOPOLE COORDINATES (NAD83)\*:

LATITUDE: 42° 38' 47.76" N

LONGITUDE: 72° 42' 46.93" W

\*PER FAA-1A

PROPOSED GROUND ELEV. AT TOWER: 578.75' (NAVD88)

PROJECT SUMMARY

SITE ADDRESS: CALL ROAD COLRAIN, MA 01340

ZONING DISTRICT:
(R) RURAL DISTRICT

PROJECT DIRECTORY

A PROPOSED 125' A.G.L. MONOPOLE, EQUIPMENT CABINETS AND DIESEL GENERATOR WILL BE INSTALLED AT GRADE INSIDE A PROPOSED 25'x50' FENCED COMPOUND. PANEL ANTENNAS & ASSOCIATED EQUIPMENT WILL BE INSTALLED ON THE PROPOSED MONOPOLE.

PROJECT DESCRIPTION

THIS DOCUMENT WAS DEVELOPED TO REFLECT A SPECIFIC SITE AND ITS SITE CONDITIONS AND IS NOT TO BE USED FOR ANOTHER SITE OR WHEN OTHER CONDITIONS PERTAIN. REUSE OF THIS DOCUMENT IS AT THE SOLE RISK OF THE USER.

A.D.A. COMPLIANCE:

FACILITY IS UNMANNED AND NOT FOR HUMAN HABITATION.

SHT. NO.	DESCRIPTION
T-1	TITLE SHEET
Z-1	ABUTTERS PLAN
Z-2	AERIAL MAP
Z-3	EXISTING CONDITIONS PLAN
Z-4	PROPOSED CONDITIONS PLAN
Z-5	ROAD PROFILE
Z-6	COMPOUND PLAN & ELEVATION
Z-7	TYPICAL DETAILS-I
Z-8	TYPICAL DETAILS-II

SHEET INDEX

TARPON
TOWERS

8916 77TH TERRACE EAST, SUITE 103 LAKEWOOD RANCH, FL 34202

**MA1231** 

ZONING		G DRAWINGS
1	02/05/25	FOR SUBMITTAL
0	01/28/25	FOR SUBMITTAL
В	01/02/25	FOR REVIEW
Α	12/20/24	FOR REVIEW



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CHECKED BY:	BBR

JOB NUMBER: 50182466

50169882

SITE LOCATION CODE:

PROJECT NUMBER:

MA1231

SITE ADDRESS


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SHEET TITLE

TITLE SHEET

SHEET NUMBER

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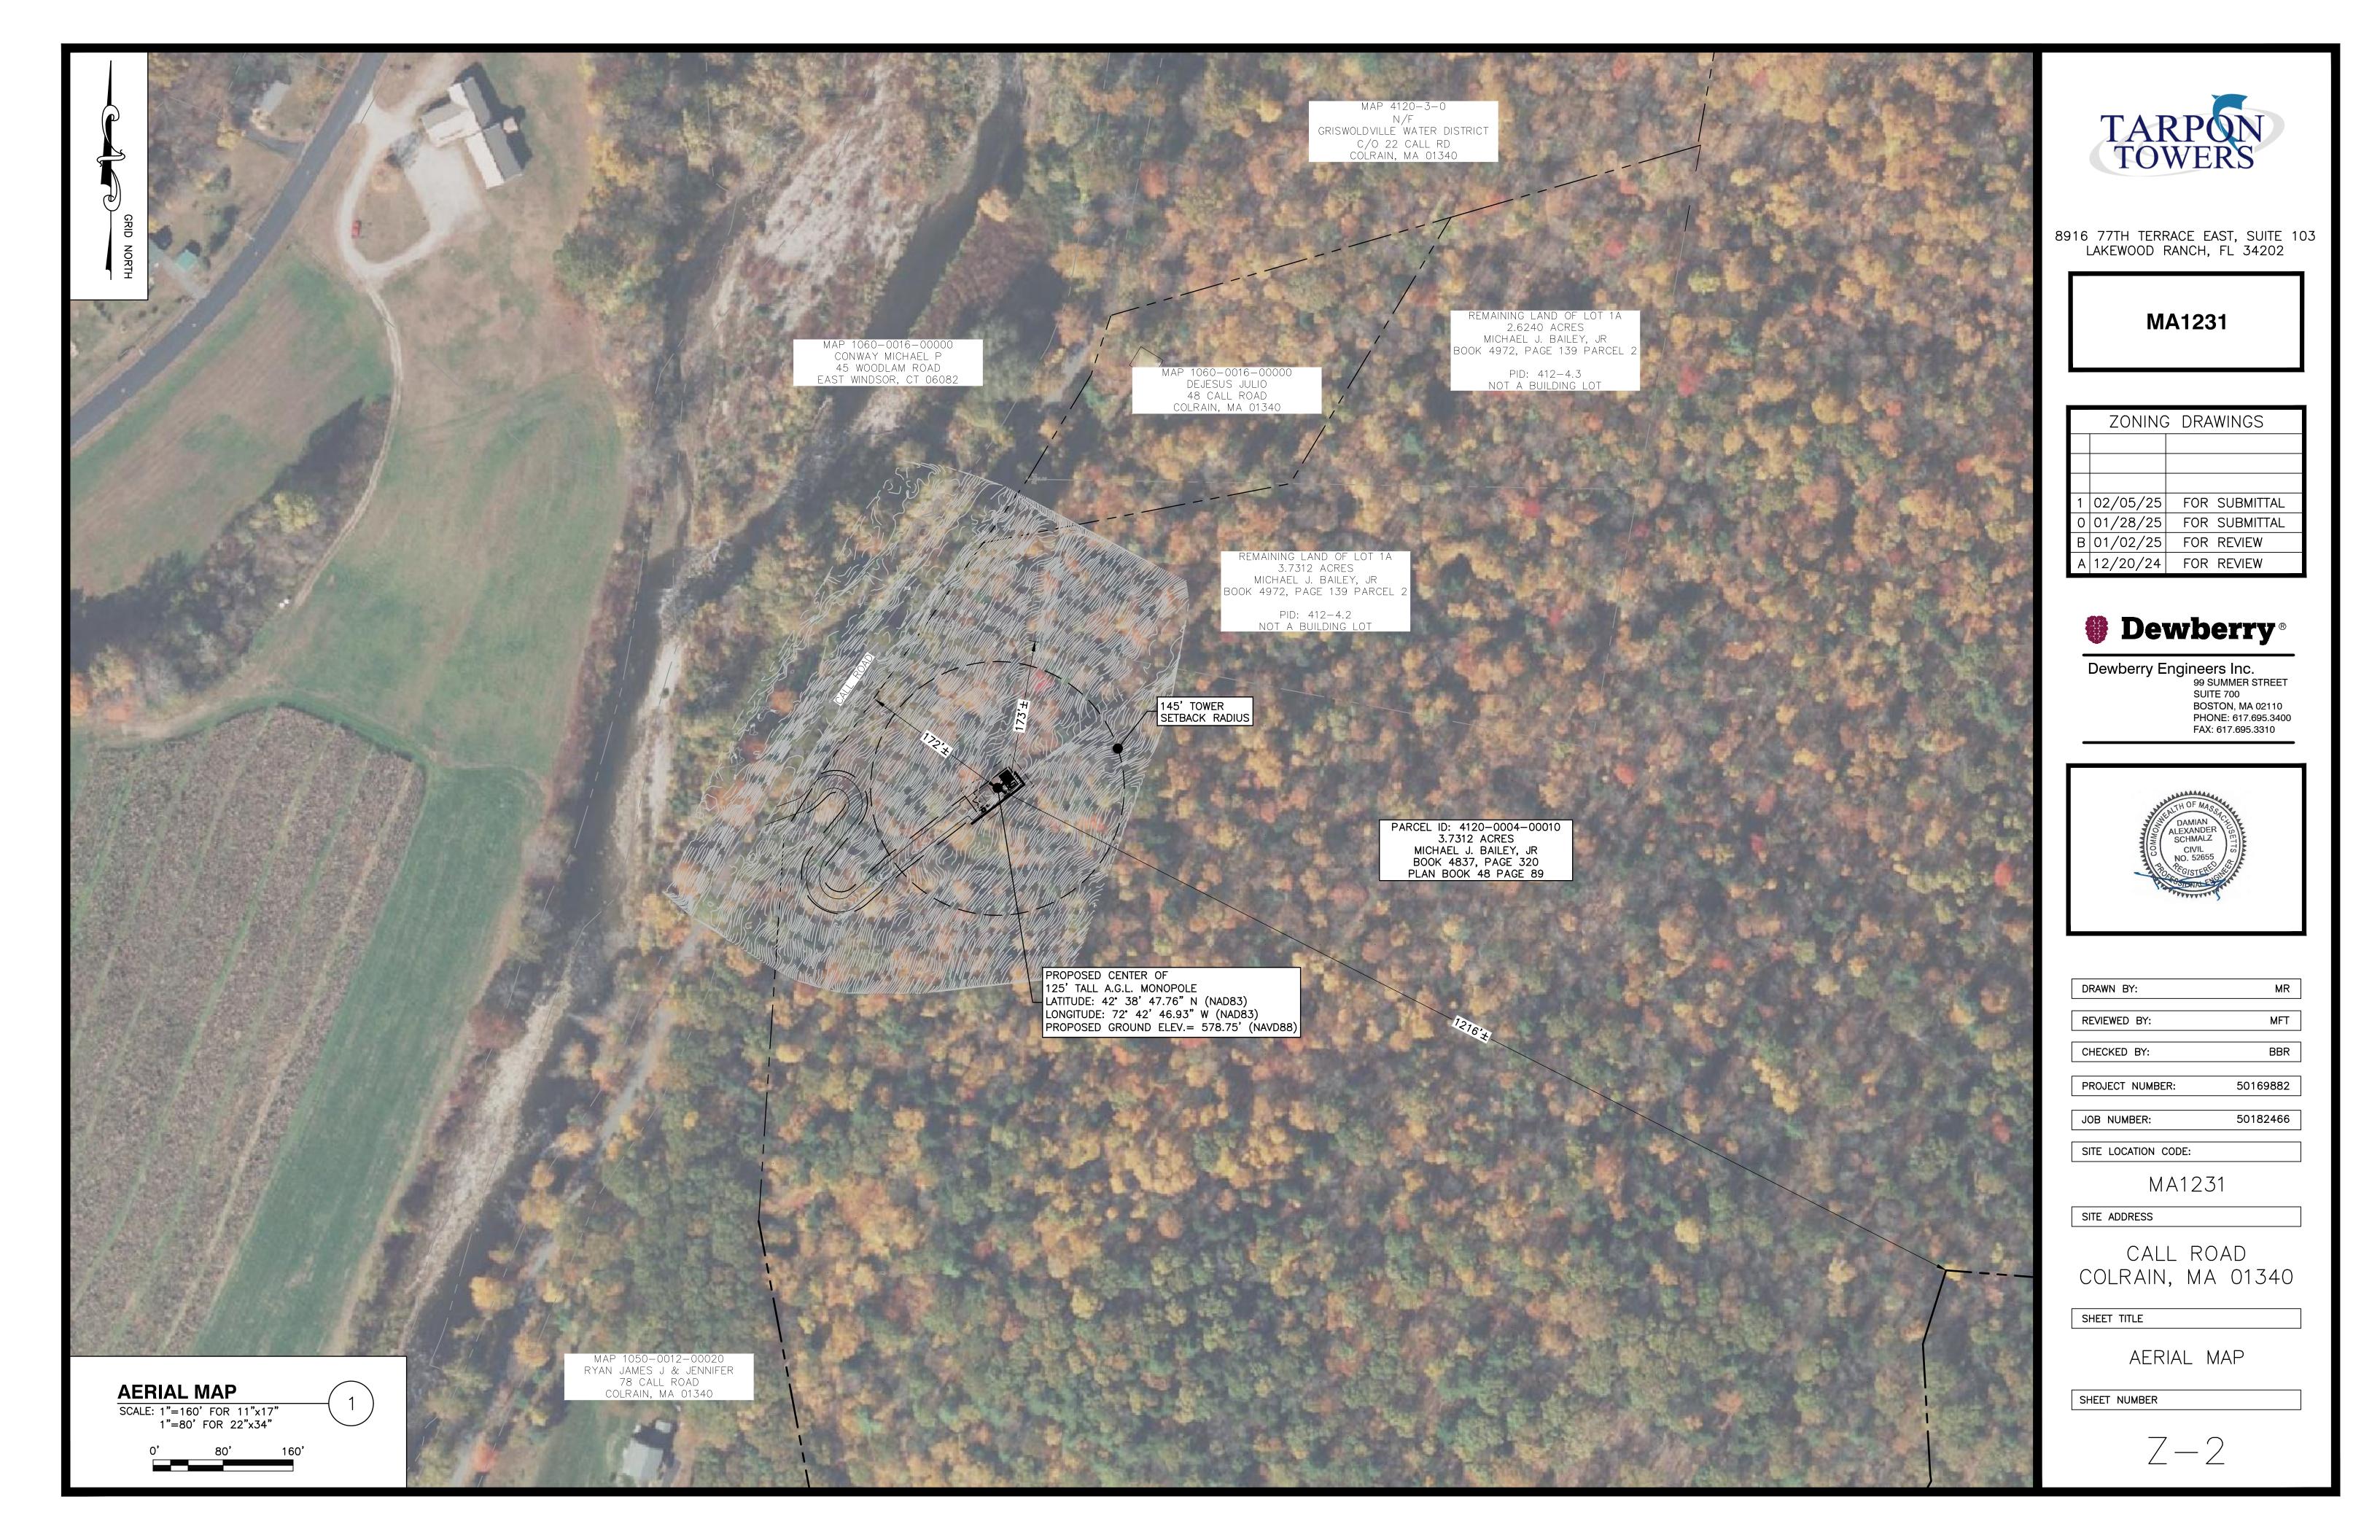
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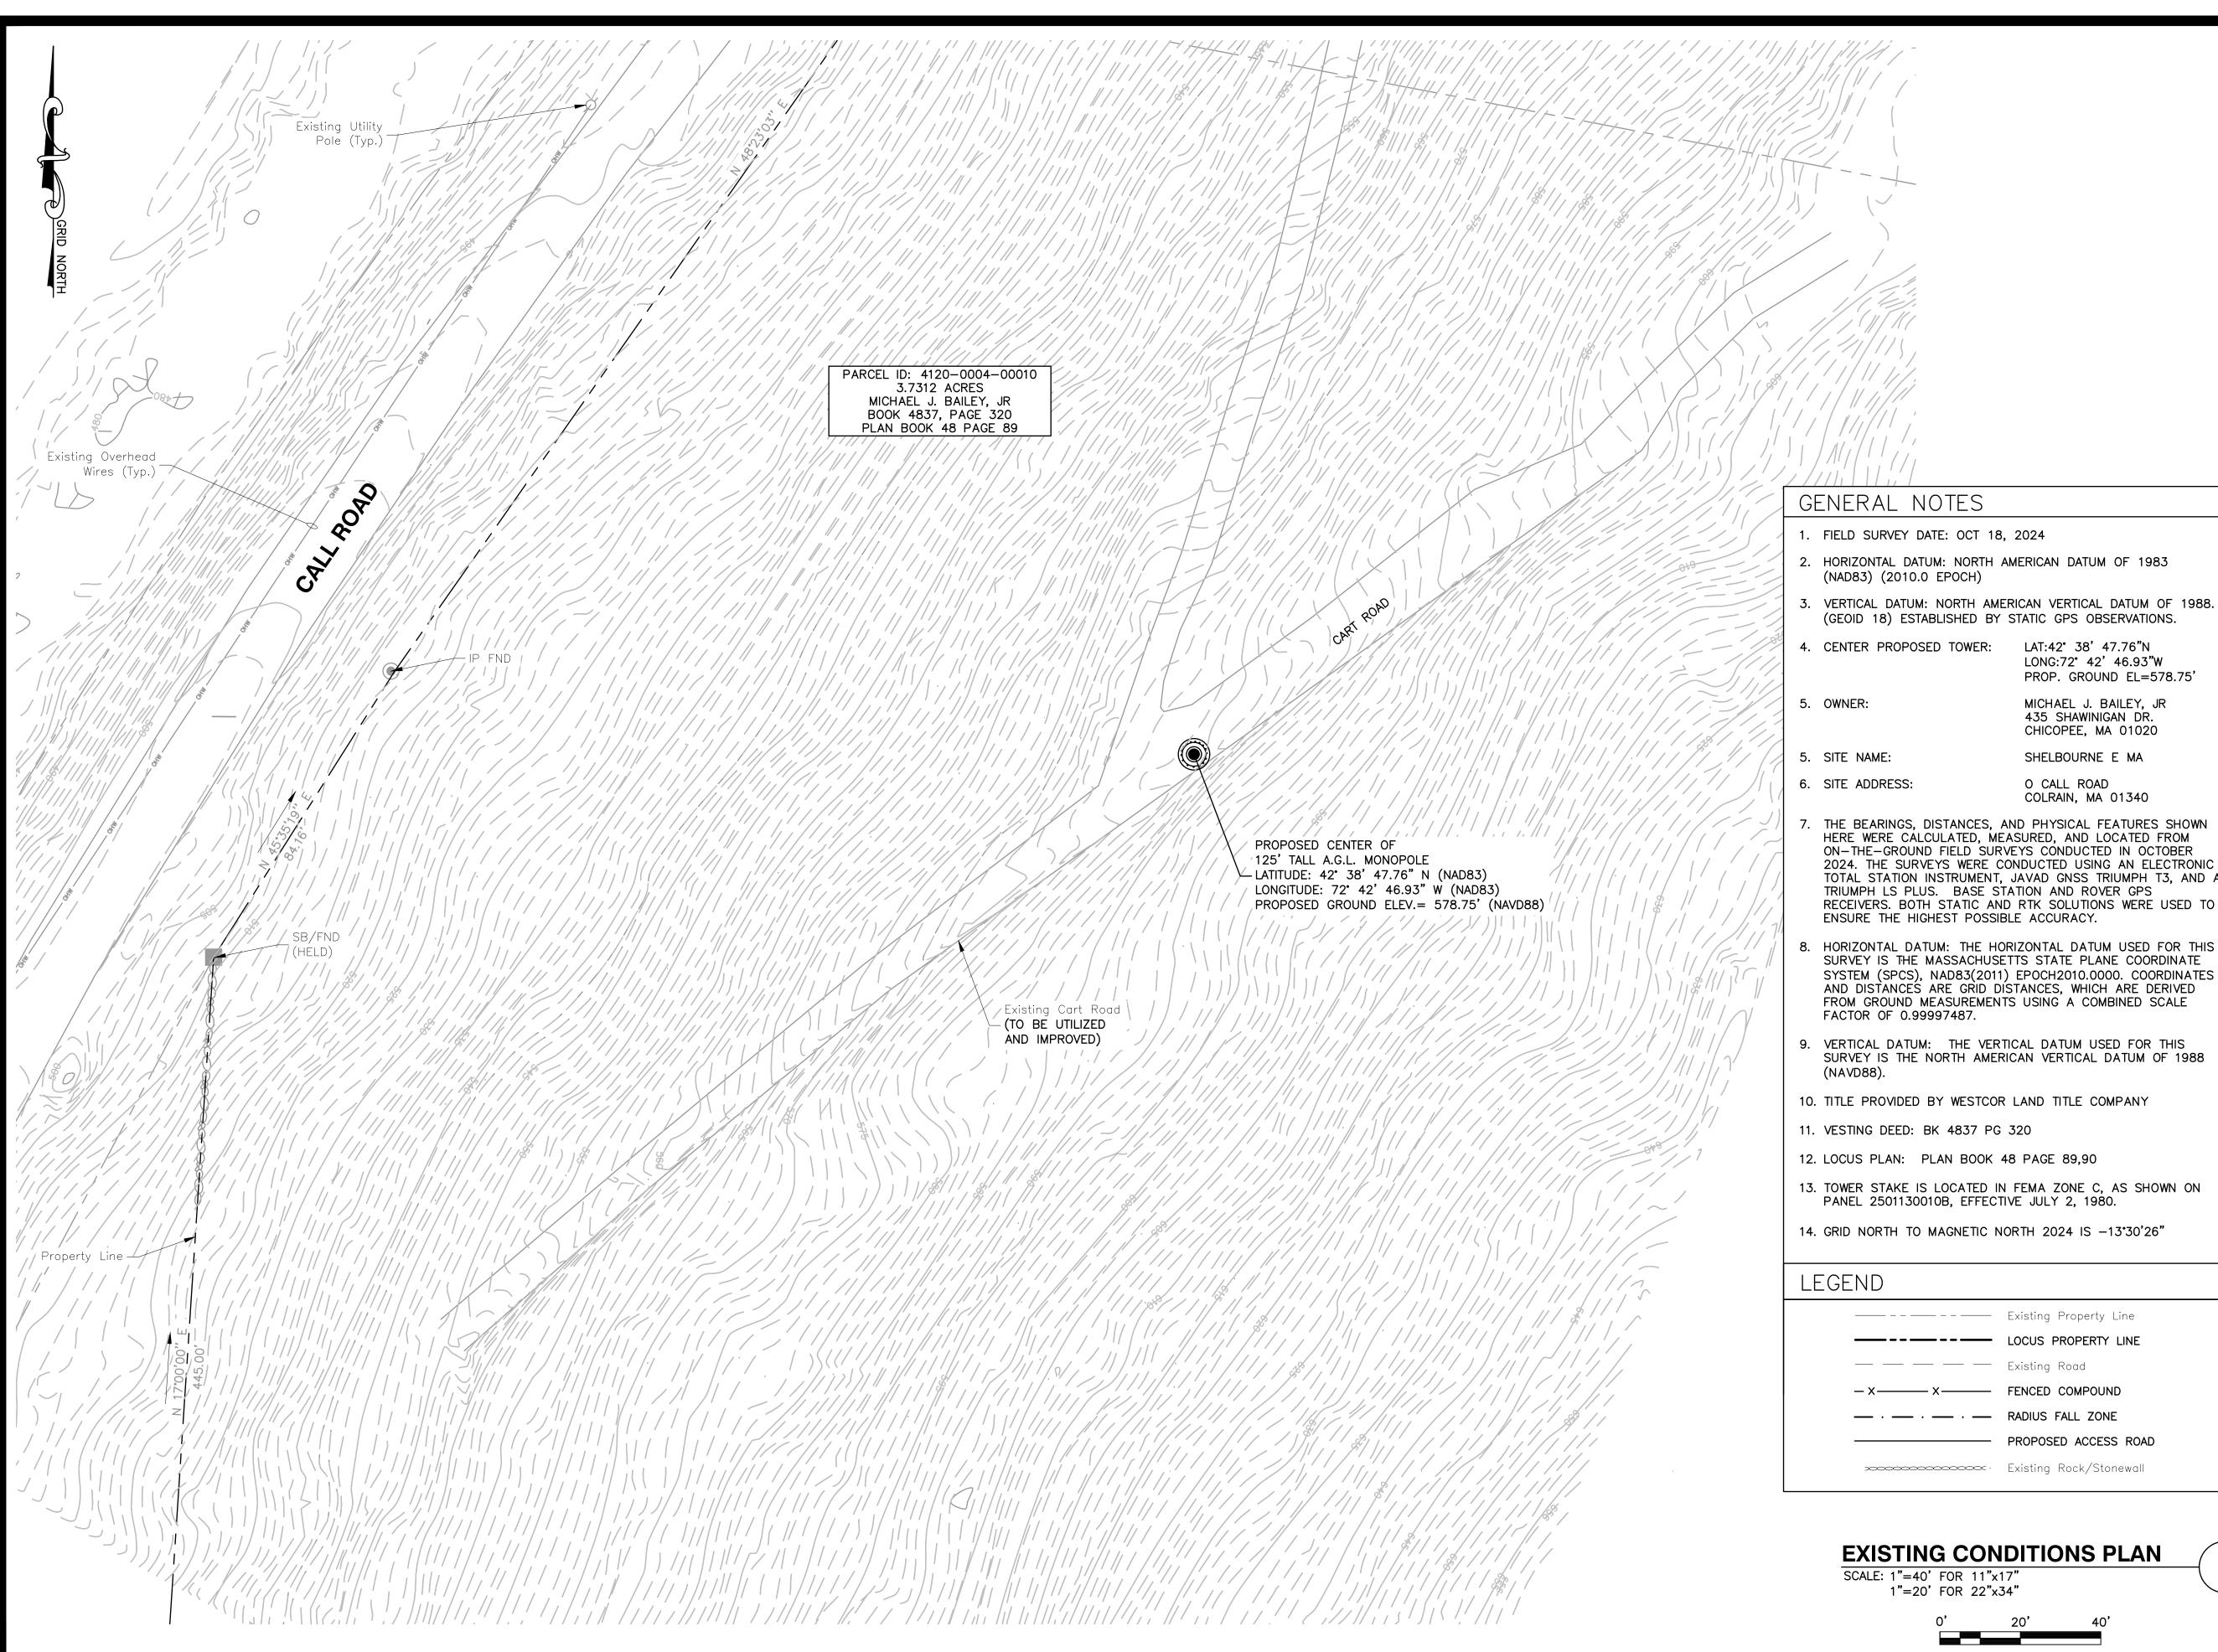
SHEET TITLE

ABUTTERS PLAN

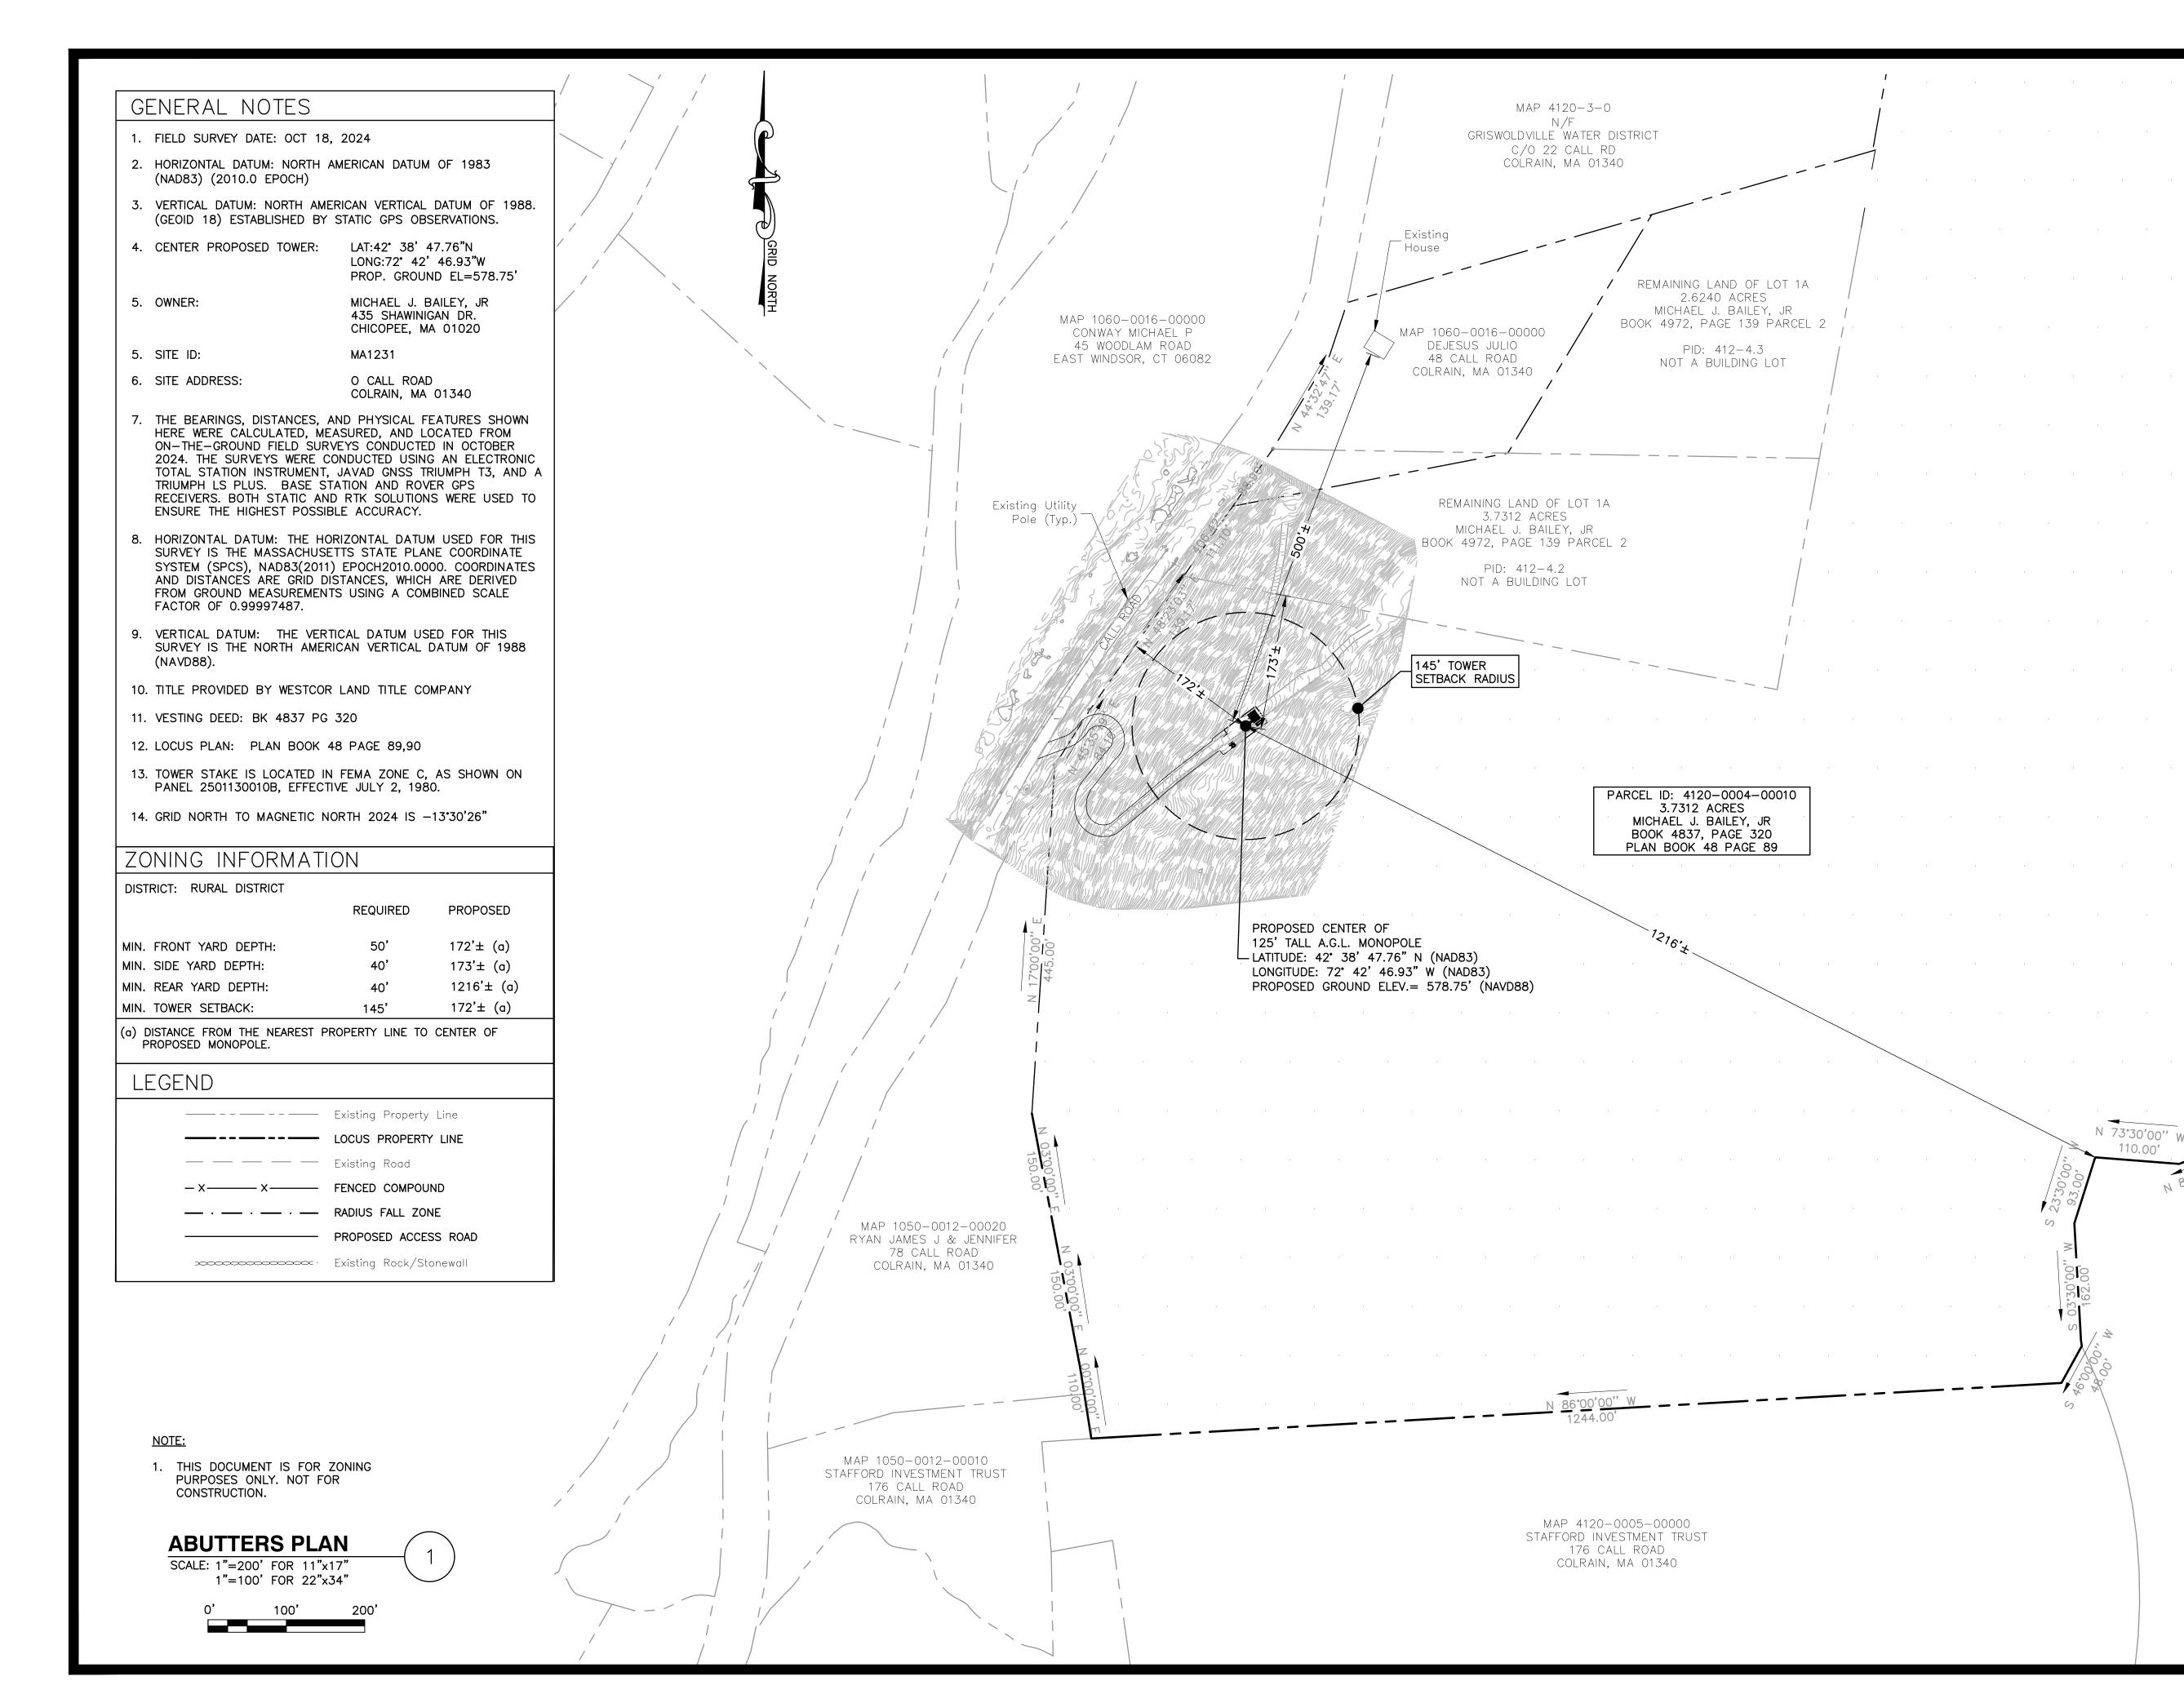SHEET NUMBER

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Α	12/20/24	FOR REVIEW

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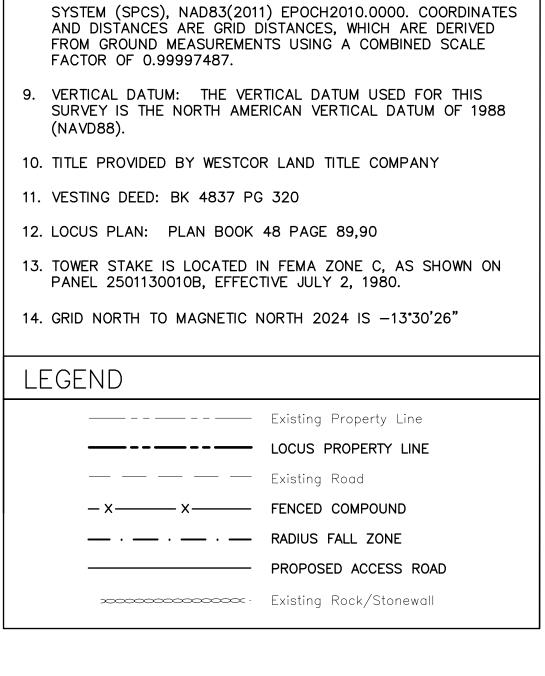
SITE ADDRESS

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SHEET TITLE

EXISTING CONDITIONS PLAN

SHEET NUMBER



**EXISTING CONDITIONS PLAN** 

SCALE: 1"=40' FOR 11"x17"

1"=20' FOR 22"x34"

(NAD83) (2010.0 EPOCH)

(GEOID 18) ESTABLISHED BY STATIC GPS OBSERVATIONS.

THE BEARINGS, DISTANCES, AND PHYSICAL FEATURES SHOWN HERE WERE CALCULATED, MEASURED, AND LOCATED FROM

2024. THE SURVEYS WERE CONDUCTED USING AN ELECTRONIC

TOTAL STATION INSTRUMENT, JAVAD GNSS TRIUMPH T3, AND A

RECEIVERS. BOTH STATIC AND RTK SOLUTIONS WERE USED TO

SURVEY IS THE MASSACHUSETTS STATE PLANE COORDINATE

ON-THE-GROUND FIELD SURVEYS CONDUCTED IN OCTOBER

TRIUMPH LS PLUS. BASE STATION AND ROVER GPS

ENSURE THE HIGHEST POSSIBLE ACCURACY.


LAT:42° 38' 47.76"N LONG:72° 42' 46.93"W PROP. GROUND EL=578.75'

MICHAEL J. BAILEY, JR 435 SHAWINIGAN DR.

CHICOPEE, MA 01020

SHELBOURNE E MA

O CALL ROAD COLRAIN, MA 01340

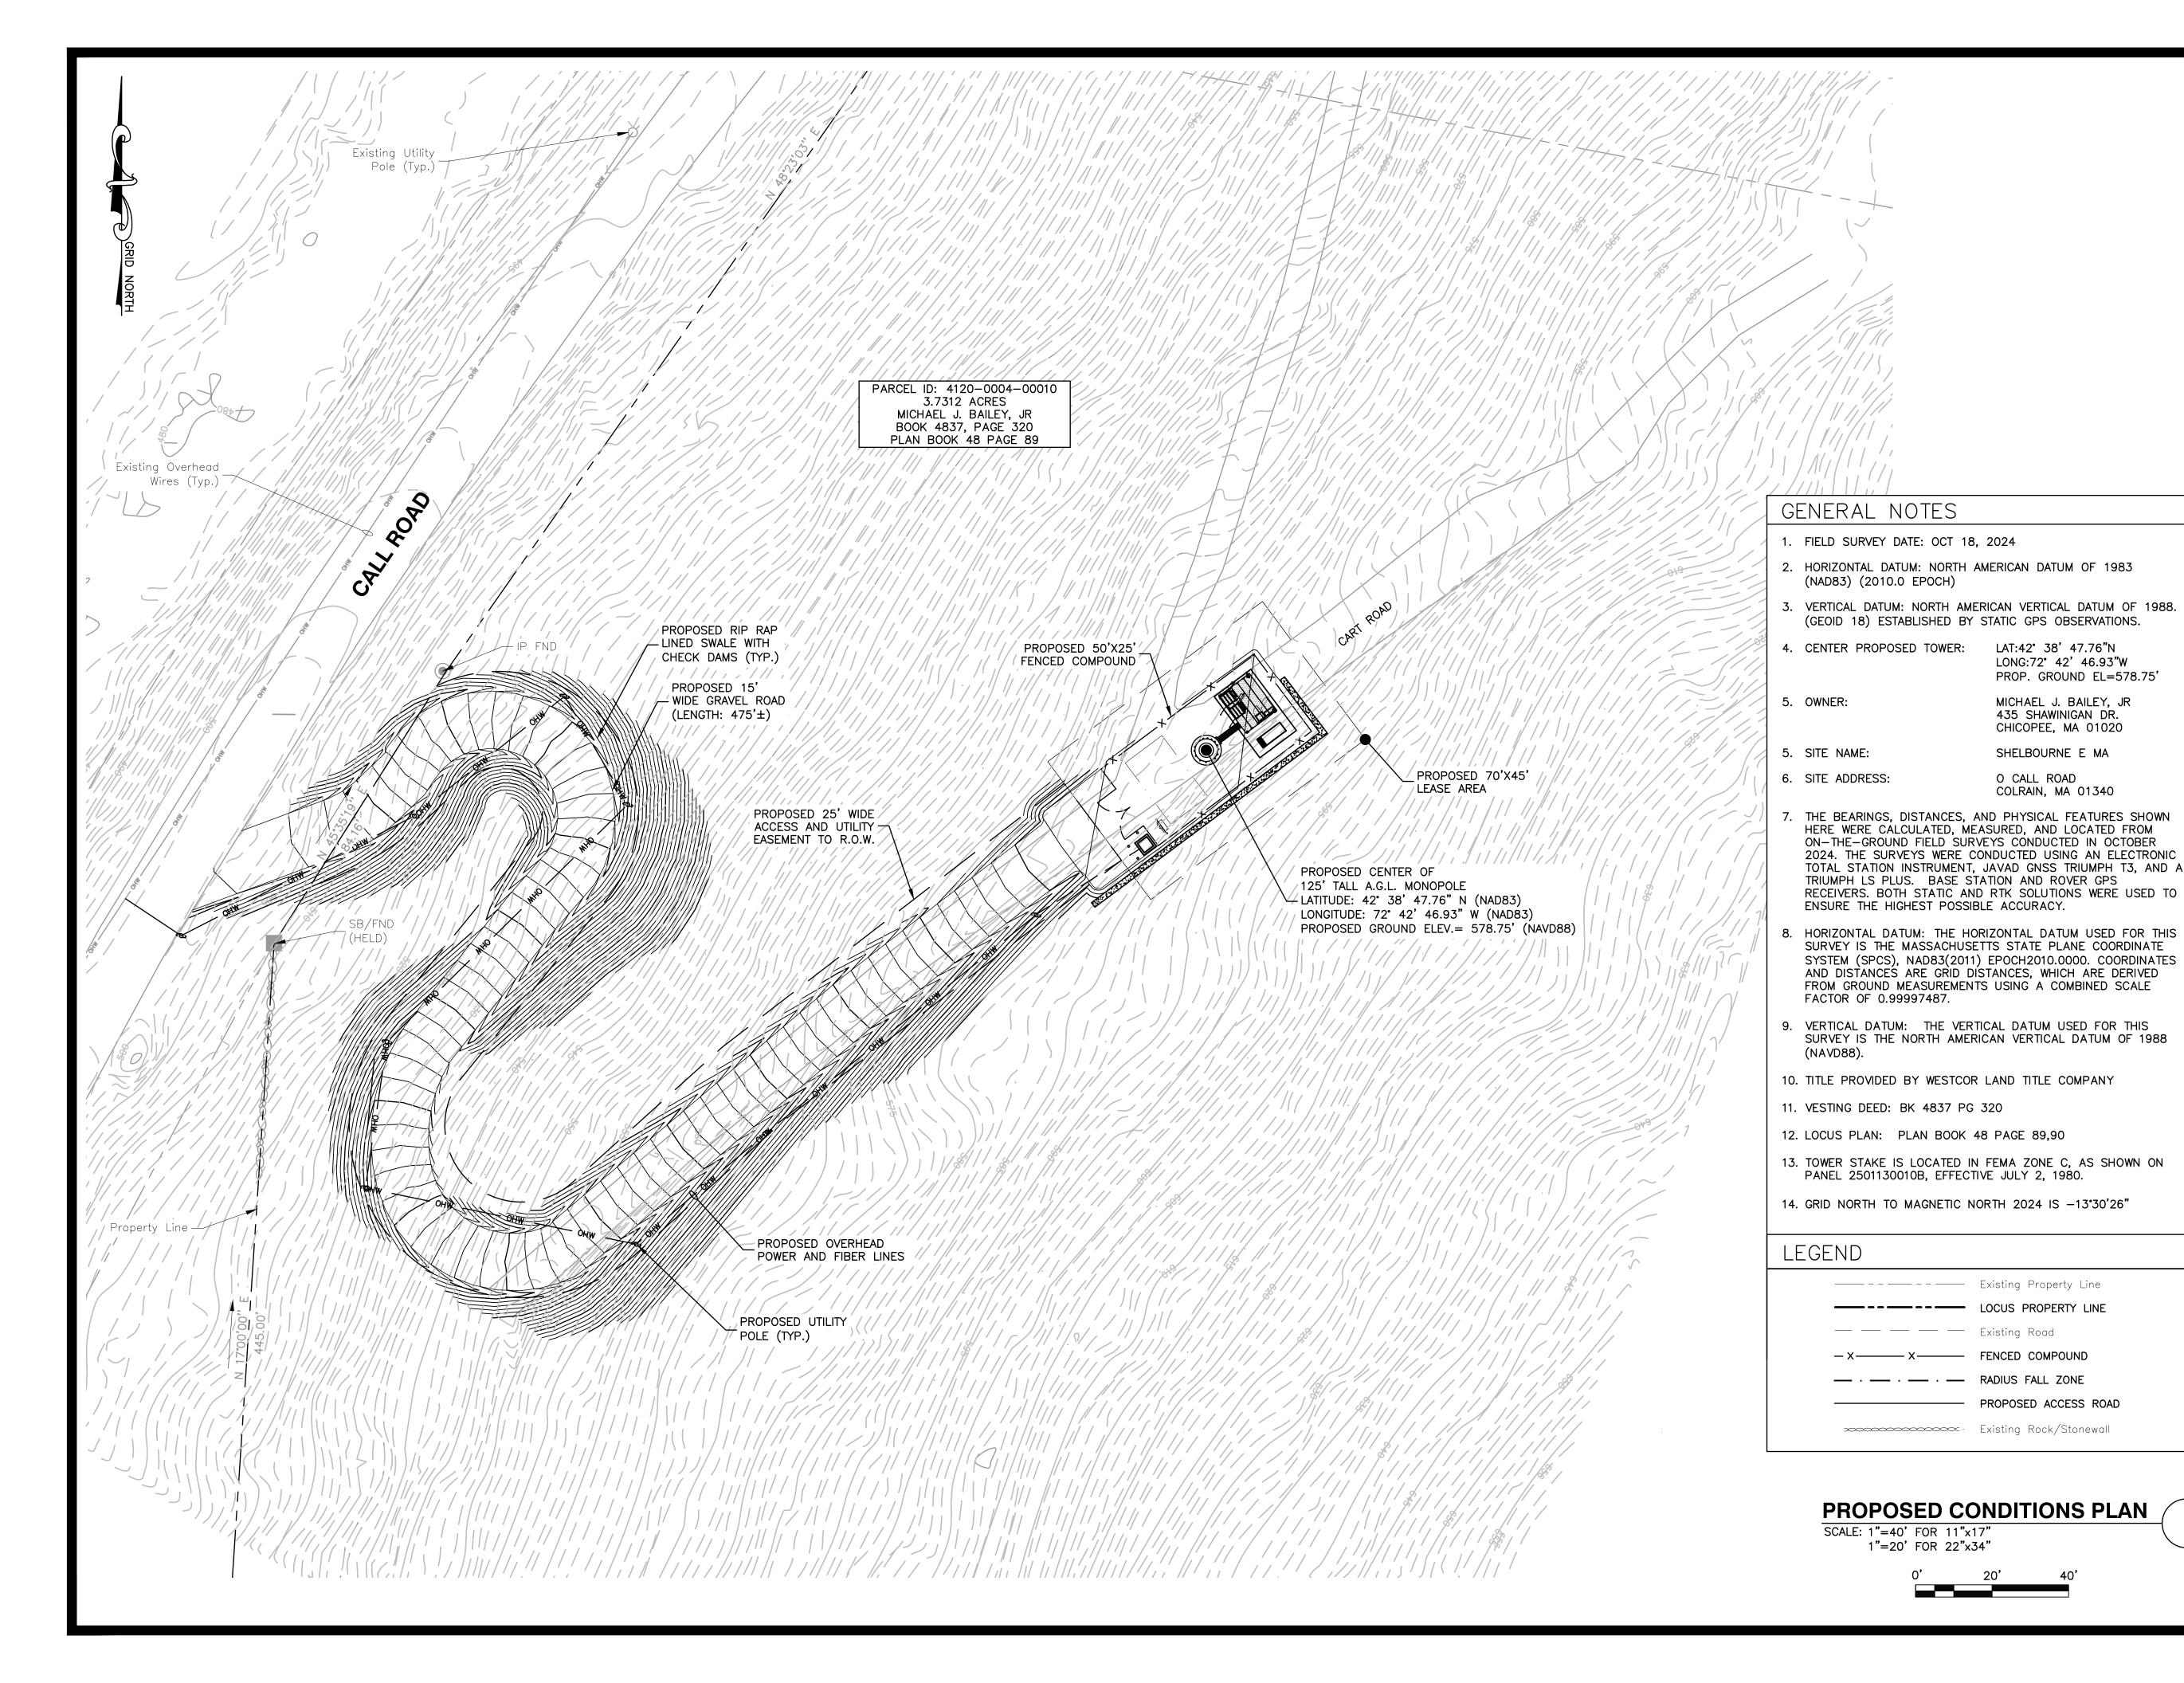



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	01/28/25	FOR SUBMITTAL	
	01/02/25	FOR REVIEW	
Α	12/20/24	FOR REVIEW	

## Dewberry®

LAT:42° 38' 47.76"N

LONG:72° 42' 46.93"W PROP. GROUND EL=578.75'

MICHAEL J. BAILEY, JR 435 SHAWINIGAN DR.

CHICOPEE, MA 01020

SHELBOURNE E MA

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— X——— FENCED COMPOUND

Existing Rock/Stonewall

1"=20' FOR 22"x34"

- RADIUS FALL ZONE

PROPOSED ACCESS ROAD

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SITE LOCATION CODE:

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SITE ADDRESS

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SHEET TITLE

PROPOSED CONDITIONS PLAN

SHEET NUMBER

### **LEGEND**


BVCS-BEGINNING OF VERTICAL CURVE STATION

BVCE-BEGINNING OF VERTICAL CURVE ELEVATION

EVCS-END OF VERTICAL CURVE STATION

EVCE-END OF VERTICAL CURVE ELEVATION

PVI -POINT OF VERTICAL INTERSECTION

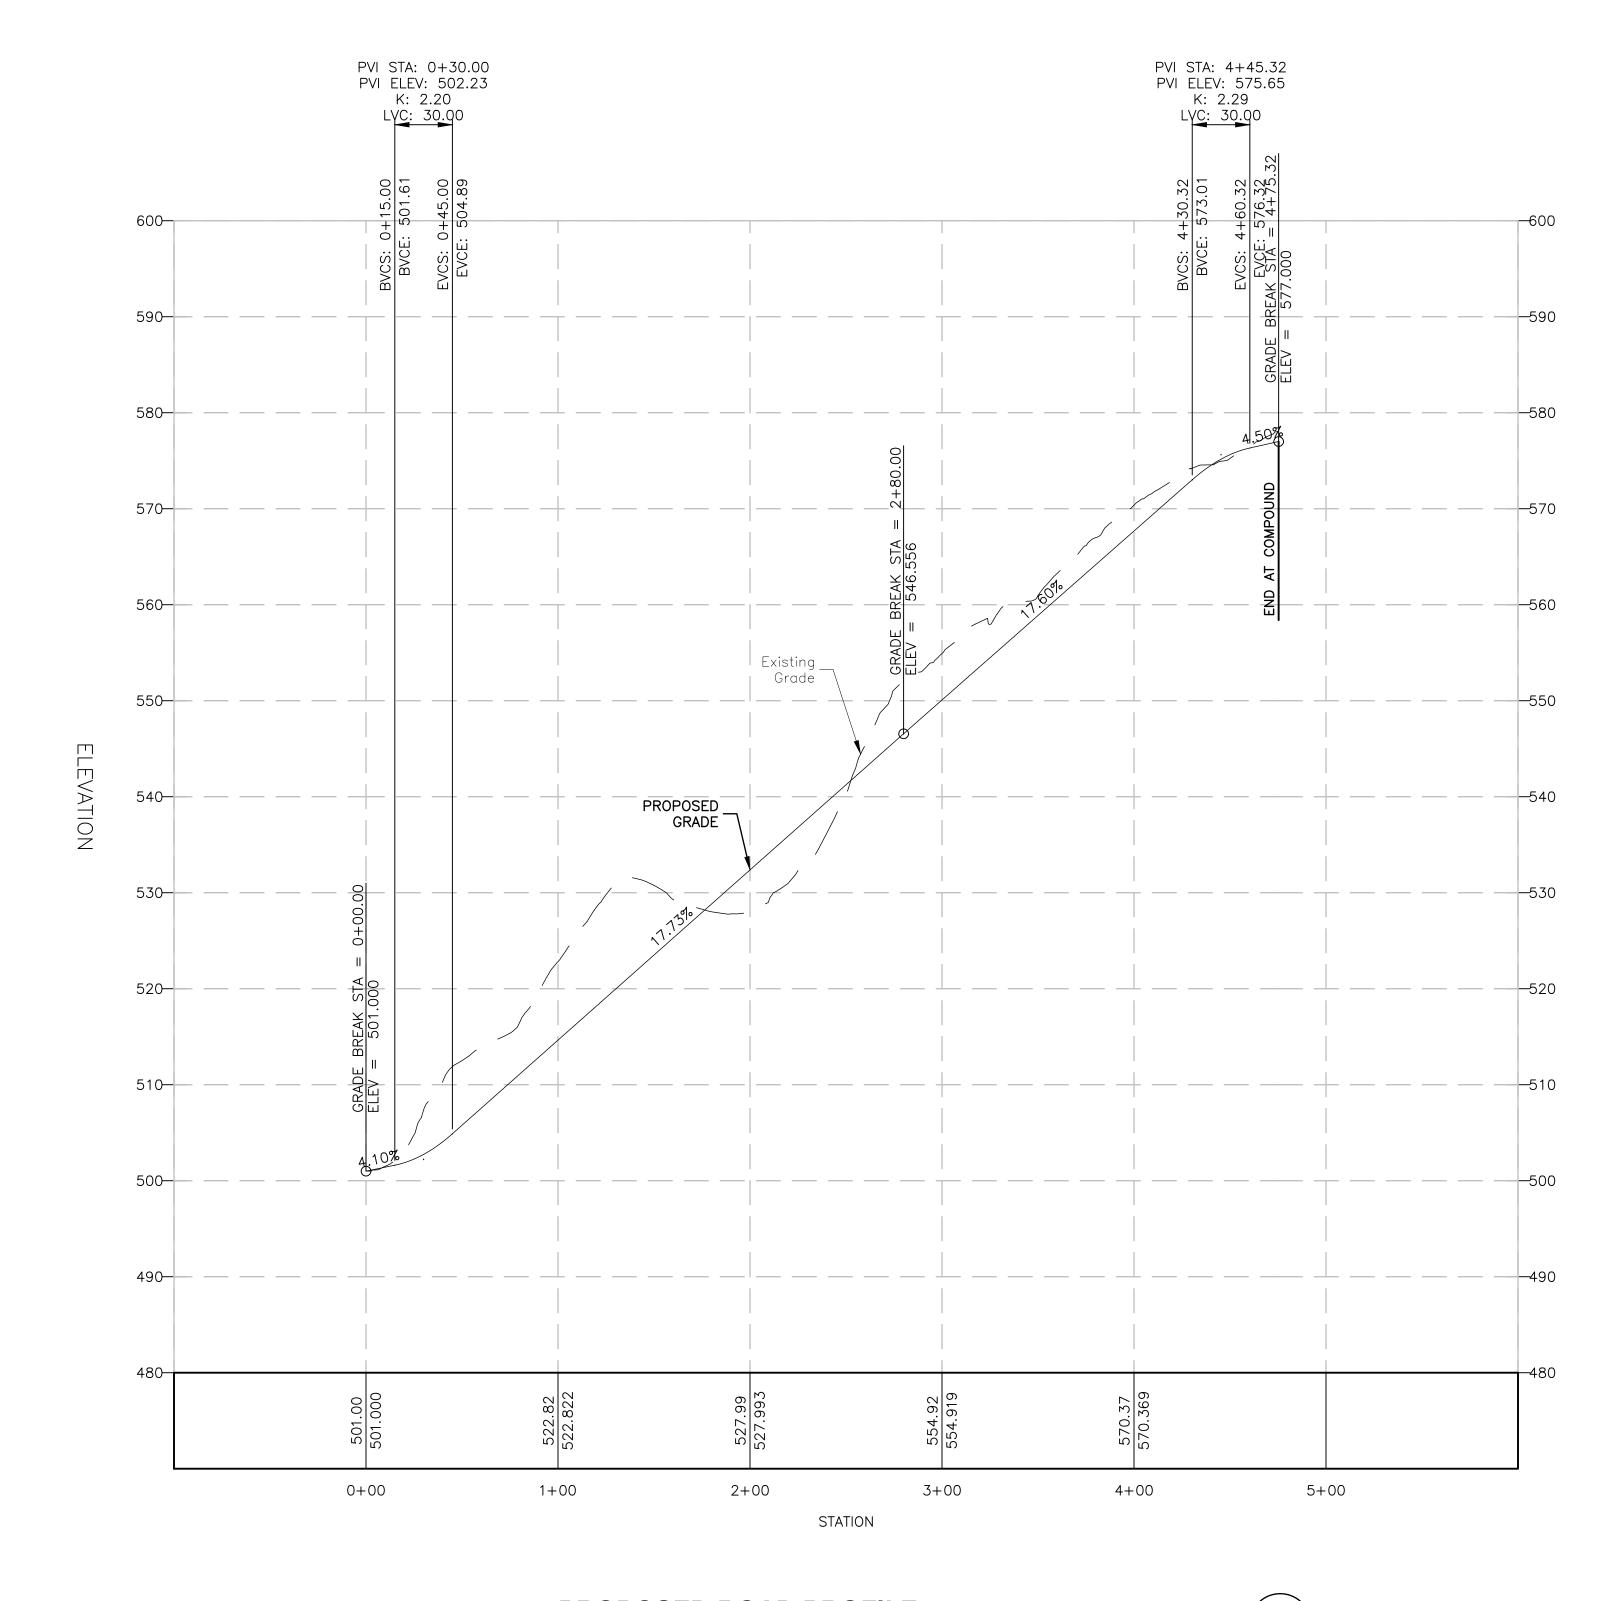


### NOTES:

- 1. PROPOSED LOCATIONS ARE CONCEPTUAL AND FOR ZONING PURPOSES ONLY.
- 2. FINAL UTILITY ROUTING PENDING FINAL UTILITY DESIGN AND LANDOWNER APPROVAL.
- TOWER AND TOWER FOUNDATION DESIGN & ANALYSIS BY OTHERS.
- 4. SOME EXISTING & FUTURE INFORMATION NOT SHOWN FOR CLARITY.
- 5. X SPOT GRADE.
  A.G.L. ABOVE GROUND LEVEL
  C.L. CENTERLINE
  NAVD88 NORTH AMERICAN VERTICAL
  DATUM OF 1988



HORIZONTAL SCALE: 1"=100' FOR 11"x17" 1"=50' FOR 22"x34" VERTICAL SCALE: 1"=10' FOR 11"x17" 1"=5' FOR 22"x34"



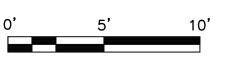



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	ZONING DRAWINGS		
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0	01/28/25	FOR SUBMITTAL	
В	01/02/25	FOR REVIEW	
Α	12/20/24	FOR REVIEW	



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 50182466

SITE LOCATION CODE:

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SITE ADDRESS


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SHEET TITLE

ROAD PROFILE

SHEET NUMBER

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CALL ROAD


COLRAIN, MA 01340

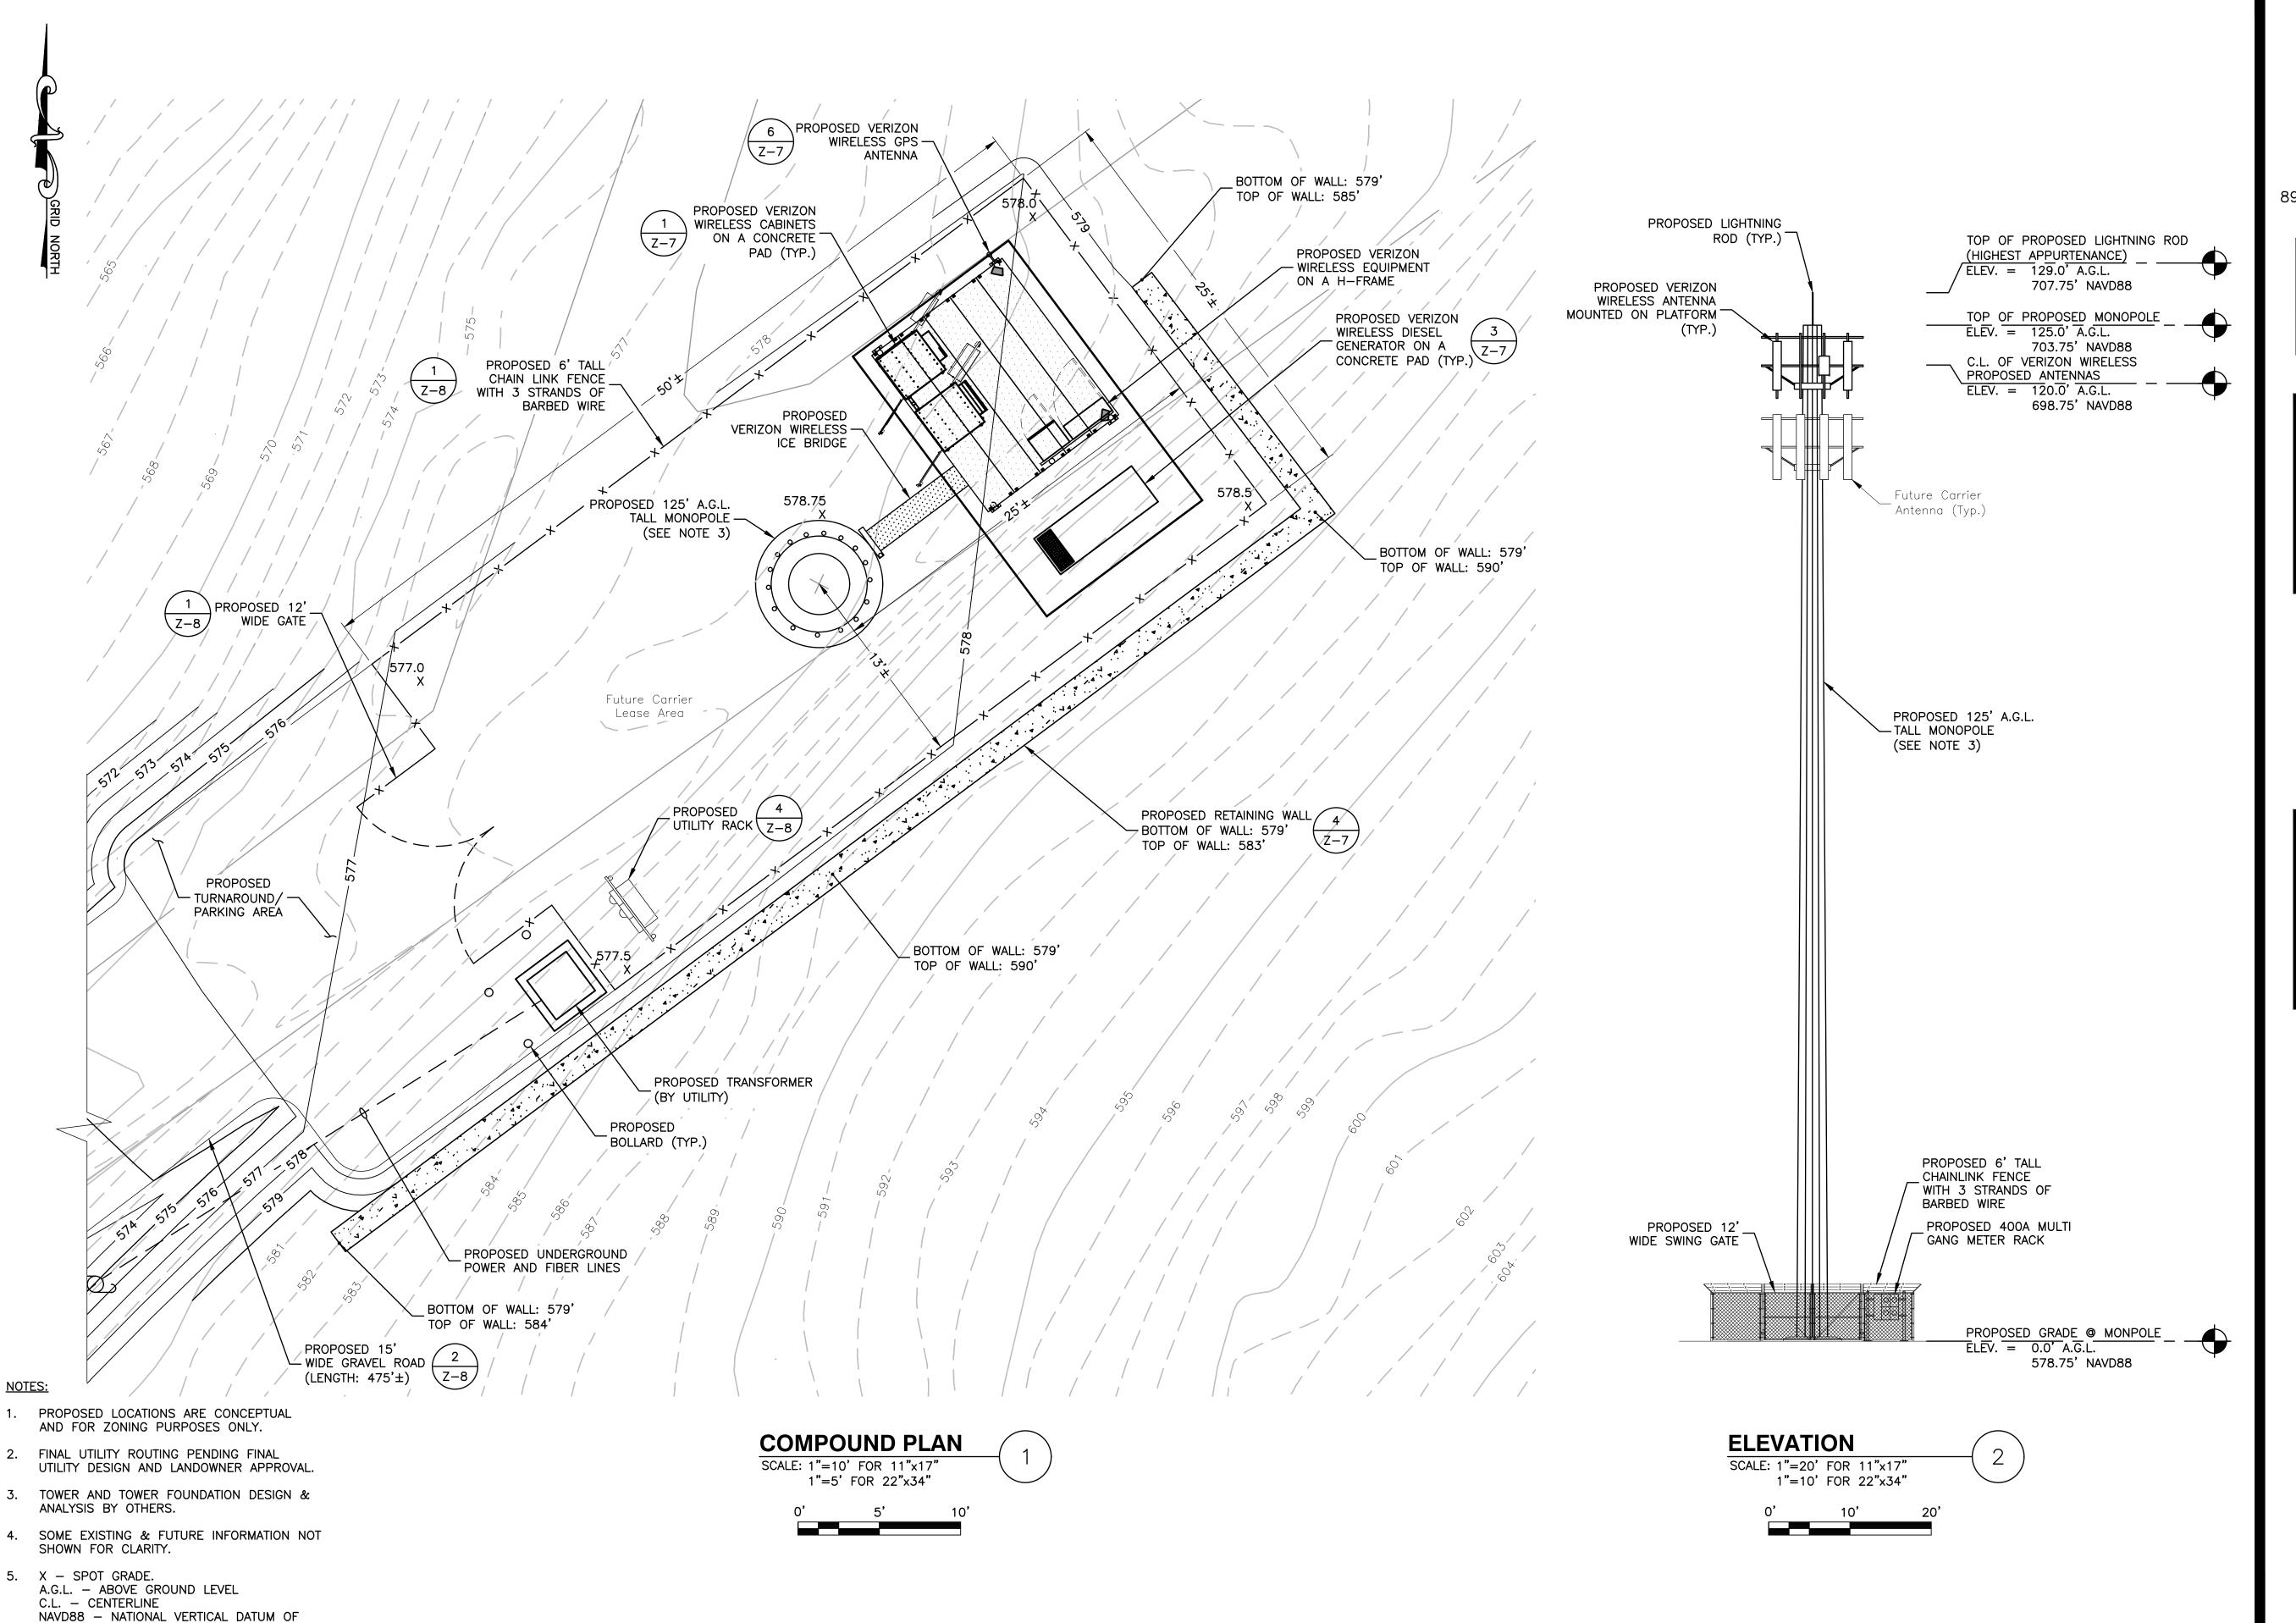
SHEET TITLE

COMPOUND PLAN & ELEVATION

SHEET NUMBER


Z-6

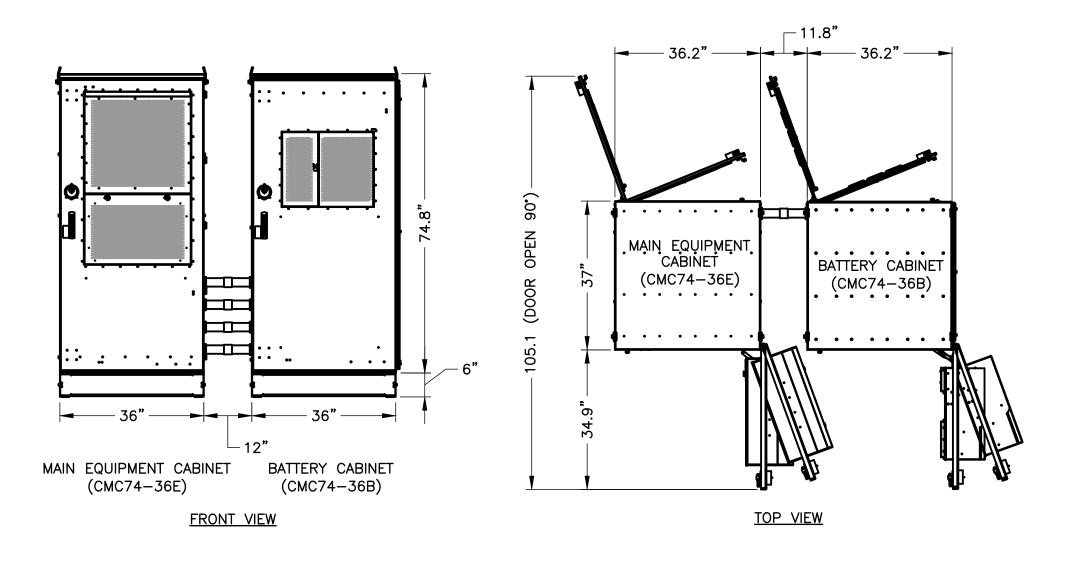

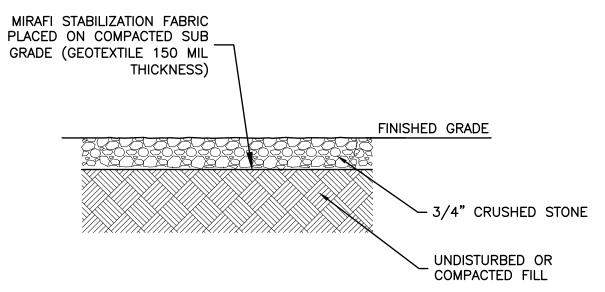

1. FILL SHALL CONSIST OF CLEAN SOIL. NO DELETERIOUS MATERIALS OR ORGANICS TO BE USED.



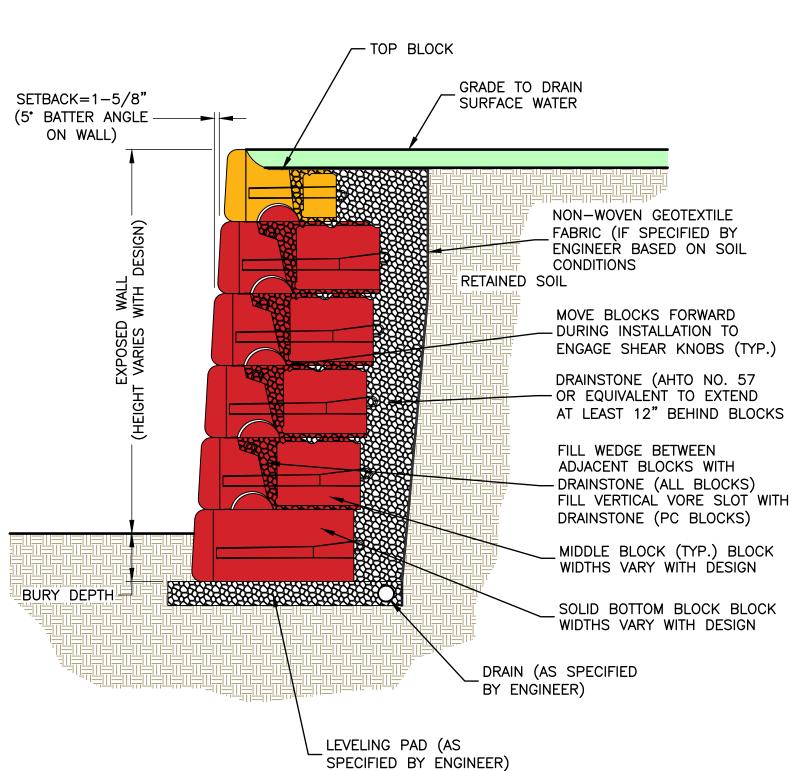


COMMSCOPE EQUIPMENT CABINETS

SCALE: 1/4"=1' FOR 11"x17"

1/2"=1' FOR 22"x34"

THIS DRAWING IS FOR REFERENCE ONLY. FINAL DESIGN BY REDI-ROCK LICENSED PROFESSIONAL ENGINEER.

### **GRAVITY RETAINING WALL SECTION** SCALE: N.T.S.

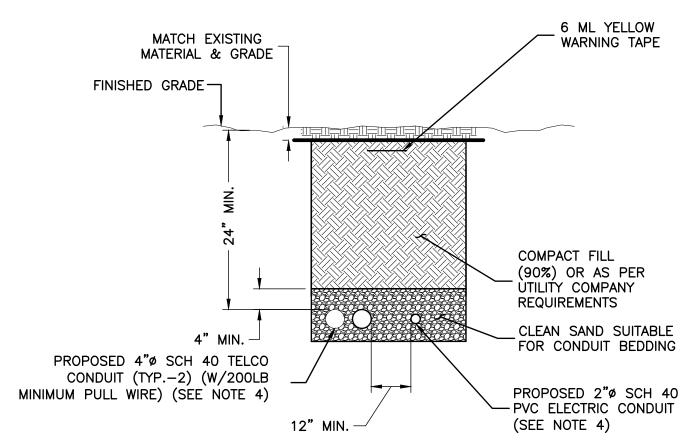

### NOTES:


- 1. IF FREE OF ORGANIC OR OTHER DELETERIOUS MATERIAL, EXCAVATED MATERIAL MAY BE USED FOR BACKFILL.
- 2. IF NOT, PROVIDE CLEAN, COMPACTIBLE MATERIAL. COMPACT IN 8" LIFTS. REMOVE ANY LARGE ROCKS PRIOR TO BACKFILLING. CONTRACTOR TO VERIFY LOCATION OF EXISTING U/G UTILITIES PRIOR TO DIGGING.
- 3. IF CURRENT AS-BUILT DRAWINGS ARE NOT AVAILABLE CONTRACTOR SHALL HAND DIG U/G TRENCHING.


### JOINT SERVICE TRENCH BURIED CONDUIT (ELECTRIC/TELEPHONE)

SCALE: N.T.S.


### NOTES:


- 1. STUB-UPS MAY VARY ON LOCATION WITH GENERATOR USED.
- 2. CONTRACTOR TO COORDINATE WITH GENERATOR MANUFACTURER FOR EXHAUST PIPE INSTALLATION WITH BULLHEAD RISER OR RAIN CAP.
- GENERATOR INSTALLATION SHALL COMPLY WITH NFPA 37 & MANUFACTURER SPECIFICATIONS.
- 4. CONTRACTOR TO VERIFY WITH C.M. FOR FINAL MANUFACTURER SPECIFICATIONS PRIOR TO CONSTRUCTION.

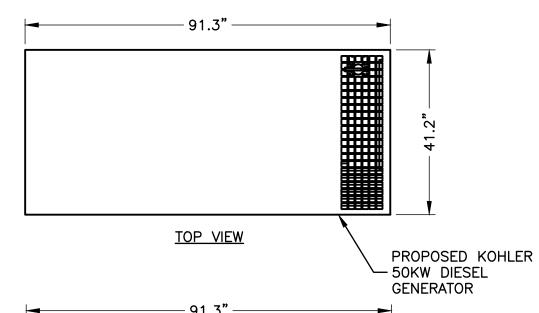

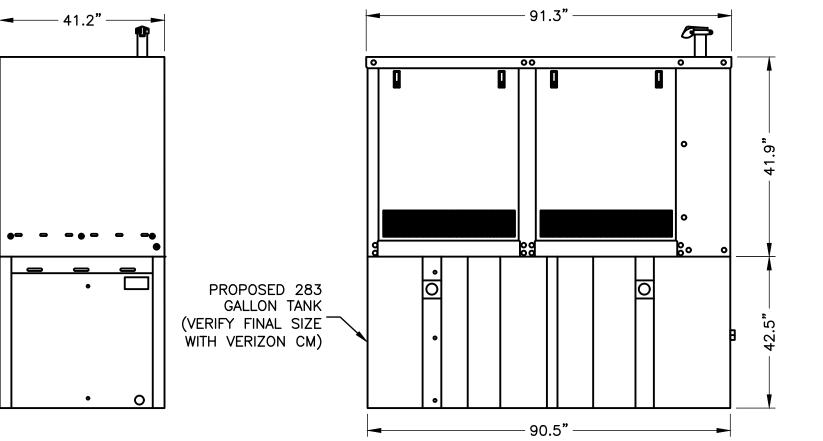

MANUFACTURER:	KOHLER
MODEL:	50REOZJE
WEIGHT:	4,700 LBS

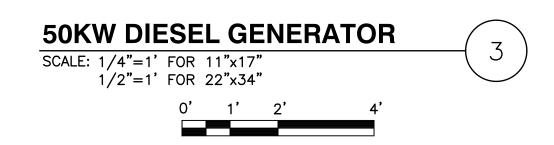

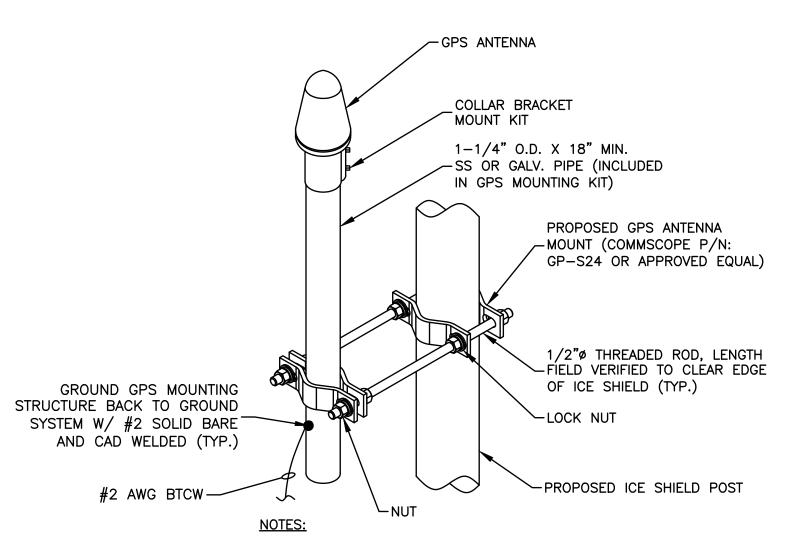

- 1. THE GPS ANTENNA MOUNT IS DESIGNED TO FASTEN TO A STANDARD 1-1/2"-3-1/2" O.D. GALVANIZED STEEL OR STAINLESS STEEL PIPE. THE PIPE MUST NOT BE THREADED AT THE ANTENNA MOUNT END.
- 2. GROUND ANTENNA & COAX MOUNTING FRAMES PER CARRIER STANDARDS.

**GPS MOUNT** SCALE: N.T.S.



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SITE LOCATION CODE:	

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SITE ADDRESS

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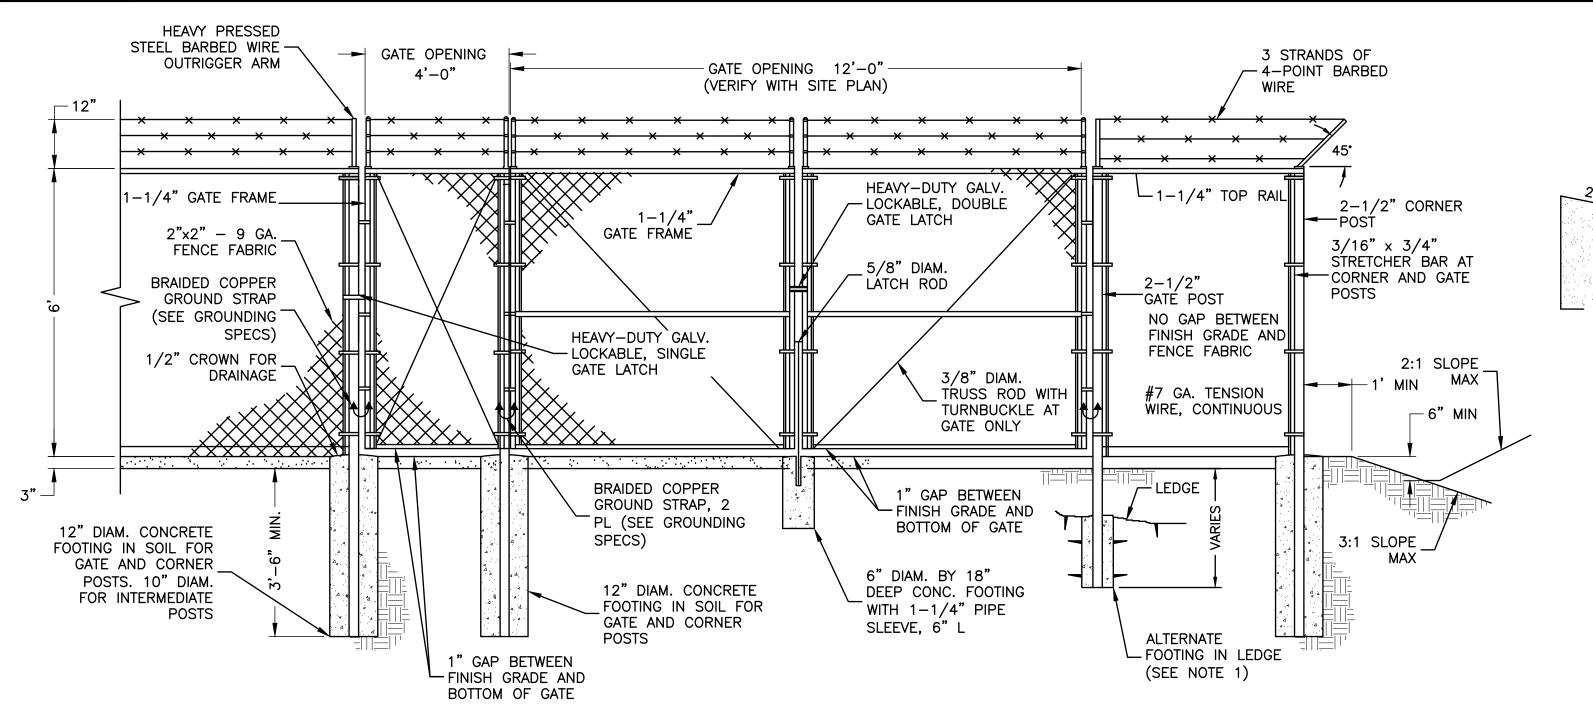
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SHEET TITLE

TYPICAL DETAILS-I

SHEET NUMBER

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### -COMPACTED SUBGRADE (MIN. 12" THICK GRAVEL PER 6" COMPACTED -NHDOT ITEM 304.2 OR CRUSHED GRAVEL TO **EQUIVALENT**) SHED WATER 15' STANDARD OR PER SITE PLAN -RIP-RAP LINED (SEE NOTE 4) SWALE (SEE NOTE 1) 2:1 SLOPE (MAX, UNO) SLOPE (SEE PLAN) \_\_\_\_ 2%, TYP. COMPACTED -INSTALL MIRAFI 140N-SUB-GRADE FABRIC OR EQUAL MIRAFI 500X (OR EQUAL) ORDINARY BORROW-STABILIZATION FABRIC ON COMPACTED SUB GRADE BACKFILL └─NO SWALE AT DOWNHILL SIDE (SEE PLAN)

### NOTES: 1. LINE SWALE WITH RIP-RAP 6" MIN. DIA. LOCATION AS NOTED ON PLANS.

- 2. SUBGRADE AND FILL SHALL CONSIST OF CLEAN SOIL. NO DELETERIOUS MATERIALS OR ORGANICS TO BE USED.
- 3. REMOVE MINIMUM OF 12" OF TOP SOIL AND ORGANICS BEFORE COMMENCING ACCESS ROAD.
- 4. CRUSHED GRAVEL TO BE PER NHDOT ITEM 304.4 OR EQUIVALENT.
- 5. THE EDGE OF GRAVEL ROADS MUST BE GRADED SUCH THAT WATER CAN FREELY FLOW TO THE ABUTTING DITCH/SWALE OR GROUND SURFACE. GRAVEL THAT FALLS INTO DRAINAGE DITCHES AND SWALES MUST BE REMOVED.

TYP. ROAD CROSS SECTION WITH SWALES

## ZONING DRAWINGS 1 | 02 / 05 / 25 | FOR SUBMITTAL 0 01/28/25 FOR SUBMITTAL B 01/02/25 FOR REVIEW A 12/20/24 FOR REVIEW


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TYPICAL DETAILS-II

SHEET NUMBER

- 1. ALTERNATE FOOTINGS FOR ALL FENCE POSTS IN LEDGE: IF LEDGE IS ENCOUNTERED AT GRADE, OR AT A DEPTH SHALLOWER THAN 3'-6", CORE DRILL AN 8" DIA HOLE 18" INTO THE LEDGE. CENTER POST IN THE HOLE AND FILL WITH CONCRETE OR GROUT. IF LEDGE IS BELOW FINISH GRADE. COAT BACKFILLED SECTION OF POST WITH COAL TAR, AND BACKFILL WITH WELL-DRAINING GRAVEL
- 2. ATTACH EACH GATE WITH 1-1/2 PAIR OF NON-LIFT-OFF TYPE, MALLEABLE IRON OR FORGING, PIN-TYPE HINGES. ASSEMBLIES SHALL ALLOW FOR 180° OF GATE TRAVEL.

### **GATE & FENCE DETAIL** SCALE: N.T.S.

### **EROSION AND SEDIMENT CONTROL PLAN:**

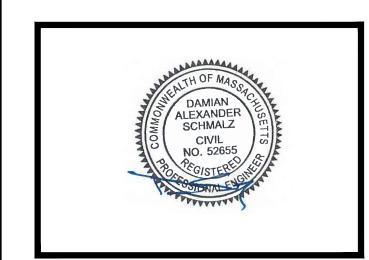DURING CONSTRUCTION AND THEREAFTER, EROSION CONTROL MEASURES ARE TO BE IMPLEMENTED AS NOTED:

- INSTALLATION OF SILTATION FENCES AND OTHER EROSION CONTROL MEASURES SHALL BE COMPLETED PRIOR TO THE START OF SITE WORK IN ANY GIVEN AREA. PREFABRICATED SILTATION FENCES SHALL BE INSTALLED ACCORDING TO THE MANUFACTURER'S RECOMMENDATIONS.
- SILTATION FENCES AND OTHER EROSION CONTROL MEASURES SHALL BE KEPT CLEAN DURING CONSTRUCTION AND REMOVED WHEN ALL SLOPES HAVE A VEGETATIVE COVER OF GREATER THAT 85%. EROSION CONTROL MEASURES SHALL BE INSPECTED ON A WEEKLY BASIS AND AFTER RAINFALL.
- 3. EXISTING VEGETATION IS TO REMAIN UNDISTURBED WHEREVER POSSIBLE.
- THE AREA OF LAND EXPOSED AND THE TIME OF EXPOSURE SHALL BE MINIMIZED. ALL DISTURBED AREAS SHALL BE STABILIZED WITHIN 72 HOURS AFTER FINAL GRADING.
- ALL DISTURBED AREAS SHALL HAVE A MINIMUM OF 6" OF LOAM. ACCEPTABLE SEED MIXES ARE AS FOLLOWS:

### WILDFLOWER SLOPE MIX 3:1 OR GREATER SLOPES (MIN. 160 LBS/ACRE):

38% CREEPING RED FESCUE (MIN. 60 LBS/ACRE) 32% PERENNIAL RYEGRASS (MIN. 51 LBS/ACRE) 5% REDTOP (MIN. 8 LBS/ACRE) (MIN. 8 LBS/ACRE) 5% ALSIKE CLOVER 5% BIRDSFOOT TREFOIL (MIN. 8 LBS/ACRE) 3% LANCE-LEAF COREOPSIS (MIN. 3 LBS/ACRE) (MIN. 3 LBS/ACRE) 3% OXEYE DANSY 3% BUTTERFLY WEED (MIN. 3 LBS/ACRE) 3% BLACKEYED SUSAN (MIN. 3 LBS/ACRE) 3% WILD LUPINE (MIN. 3 LBS/ACRE)


GENERAL SLOPE MIX 3:1 OR GREATER SLOPES (MIN. 160 LBS/ACRE):

44% CREEPING RED FESCUE (MIN. 70 LBS/ACRE) 38% PERENNIAL RYEGRASS (MIN. 60 LBS/ACRE) (MIN. 10 LBS/ACRE) 6% REDTOP

A. PLACING LOAM ON SITE:

**FENCE NOTES:** 

- ALL SUBGRADE ELEVATIONS SHOULD BE UNIFORMLY GRADED TO RECEIVE LOAM AND SHALL BE INSPECTED AND APPROVED BY THE GENERAL CONTRACTOR PRIOR TO PLACEMENT OF LOAM.
- PLACE LOAM TO FORM A MINIMUM DEPTH OF 4" WHEN ROLLED, UNLESS OTHERWISE INDICATED.
- ALL DEPRESSIONS EXPOSED DURING THE ROLLING SHALL BE FILLED WITH ADDITIONAL LOAM.
- SEED BED PREPARATION: AFTER FINISH GRADING AND JUST BEFORE SEEDING, THE AREAS TO BE SEEDED SHALL BE LOOSENED TO PROVIDE A ROUGH, FIRM BUT FINELY PULVERIZED SEEDBED. THE INTENT IS TEXTTURE CAPABLE OF RETAINING WATER, SEED SHALL BE APPLIED TO THE CONDITIONED SEEDBED NOT MORE THAN 48 HOURS AFTER THE SEEDBED HAS BEEN PREPARED.

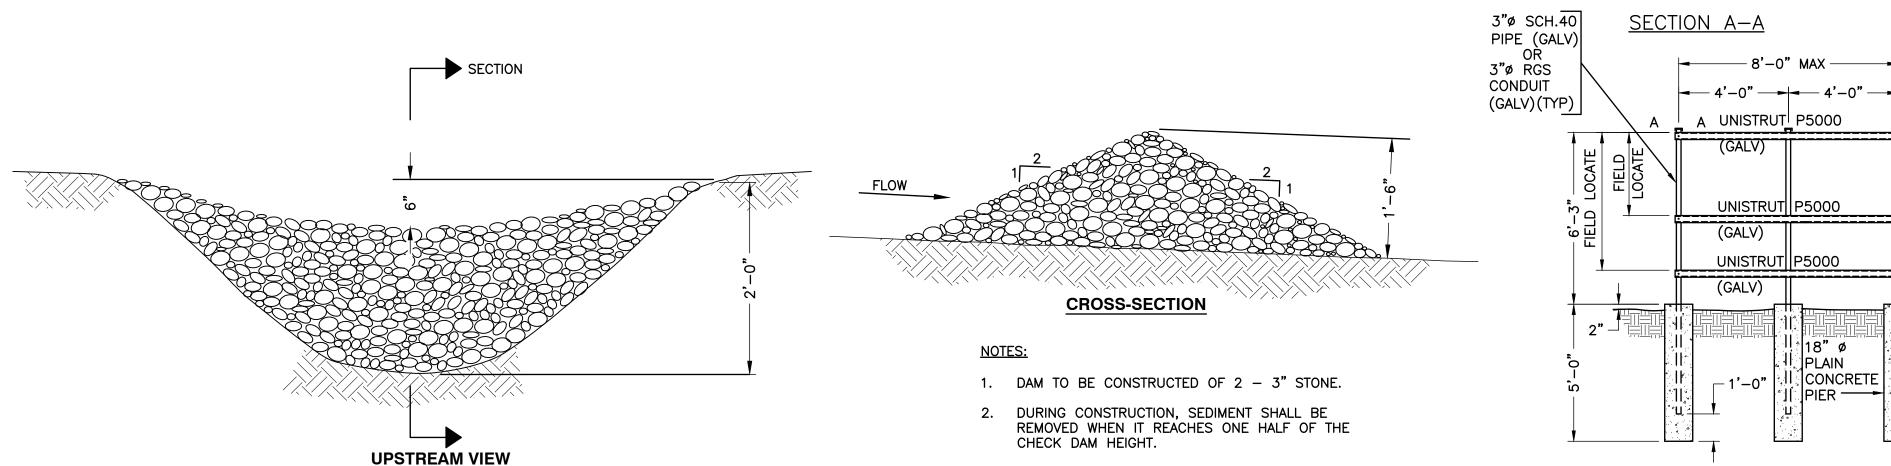

CHECK DAM DETAIL

**UTILITY MOUNTING RACK DETAIL** 

UNISTRUT PIPE/CONDUIT

FOR BOLT TORQUE

PLAIN

\*Ji PIER ---

|| CONCRETE |

CLAMP P1119 OR P2558-35

PIPE CAP

FINISHED

GRADE

GALV.) (TYPICAL) FOLLOW MANUF. RECOMMENDATIONS

SCALE: N.T.S.

O.D. POST